



SHEET NOTE:

1. FOR EQUIPMENT TO BE DEMOLISHED: ALL EXISTING CONDUIT AND WIRING SHALL BE REMOVED. PERMISSION TO USE EXISTING CONDUIT (WIRES REMOVED) SHALL BE REQUIRED FROM WMATA ENGINEER.

- PLAN NOTE:
- ① EXISTING CIRCUIT BREAKER TO BE REMOVED.
- ② EXISTING DISCONNECT SWITCH TO REMAIN.
- ③ EXISTING MOTOR STARTER TO BE REMOVED.
- ④ EXISTING MOTOR CONTROLLER TO BE REMOVED.

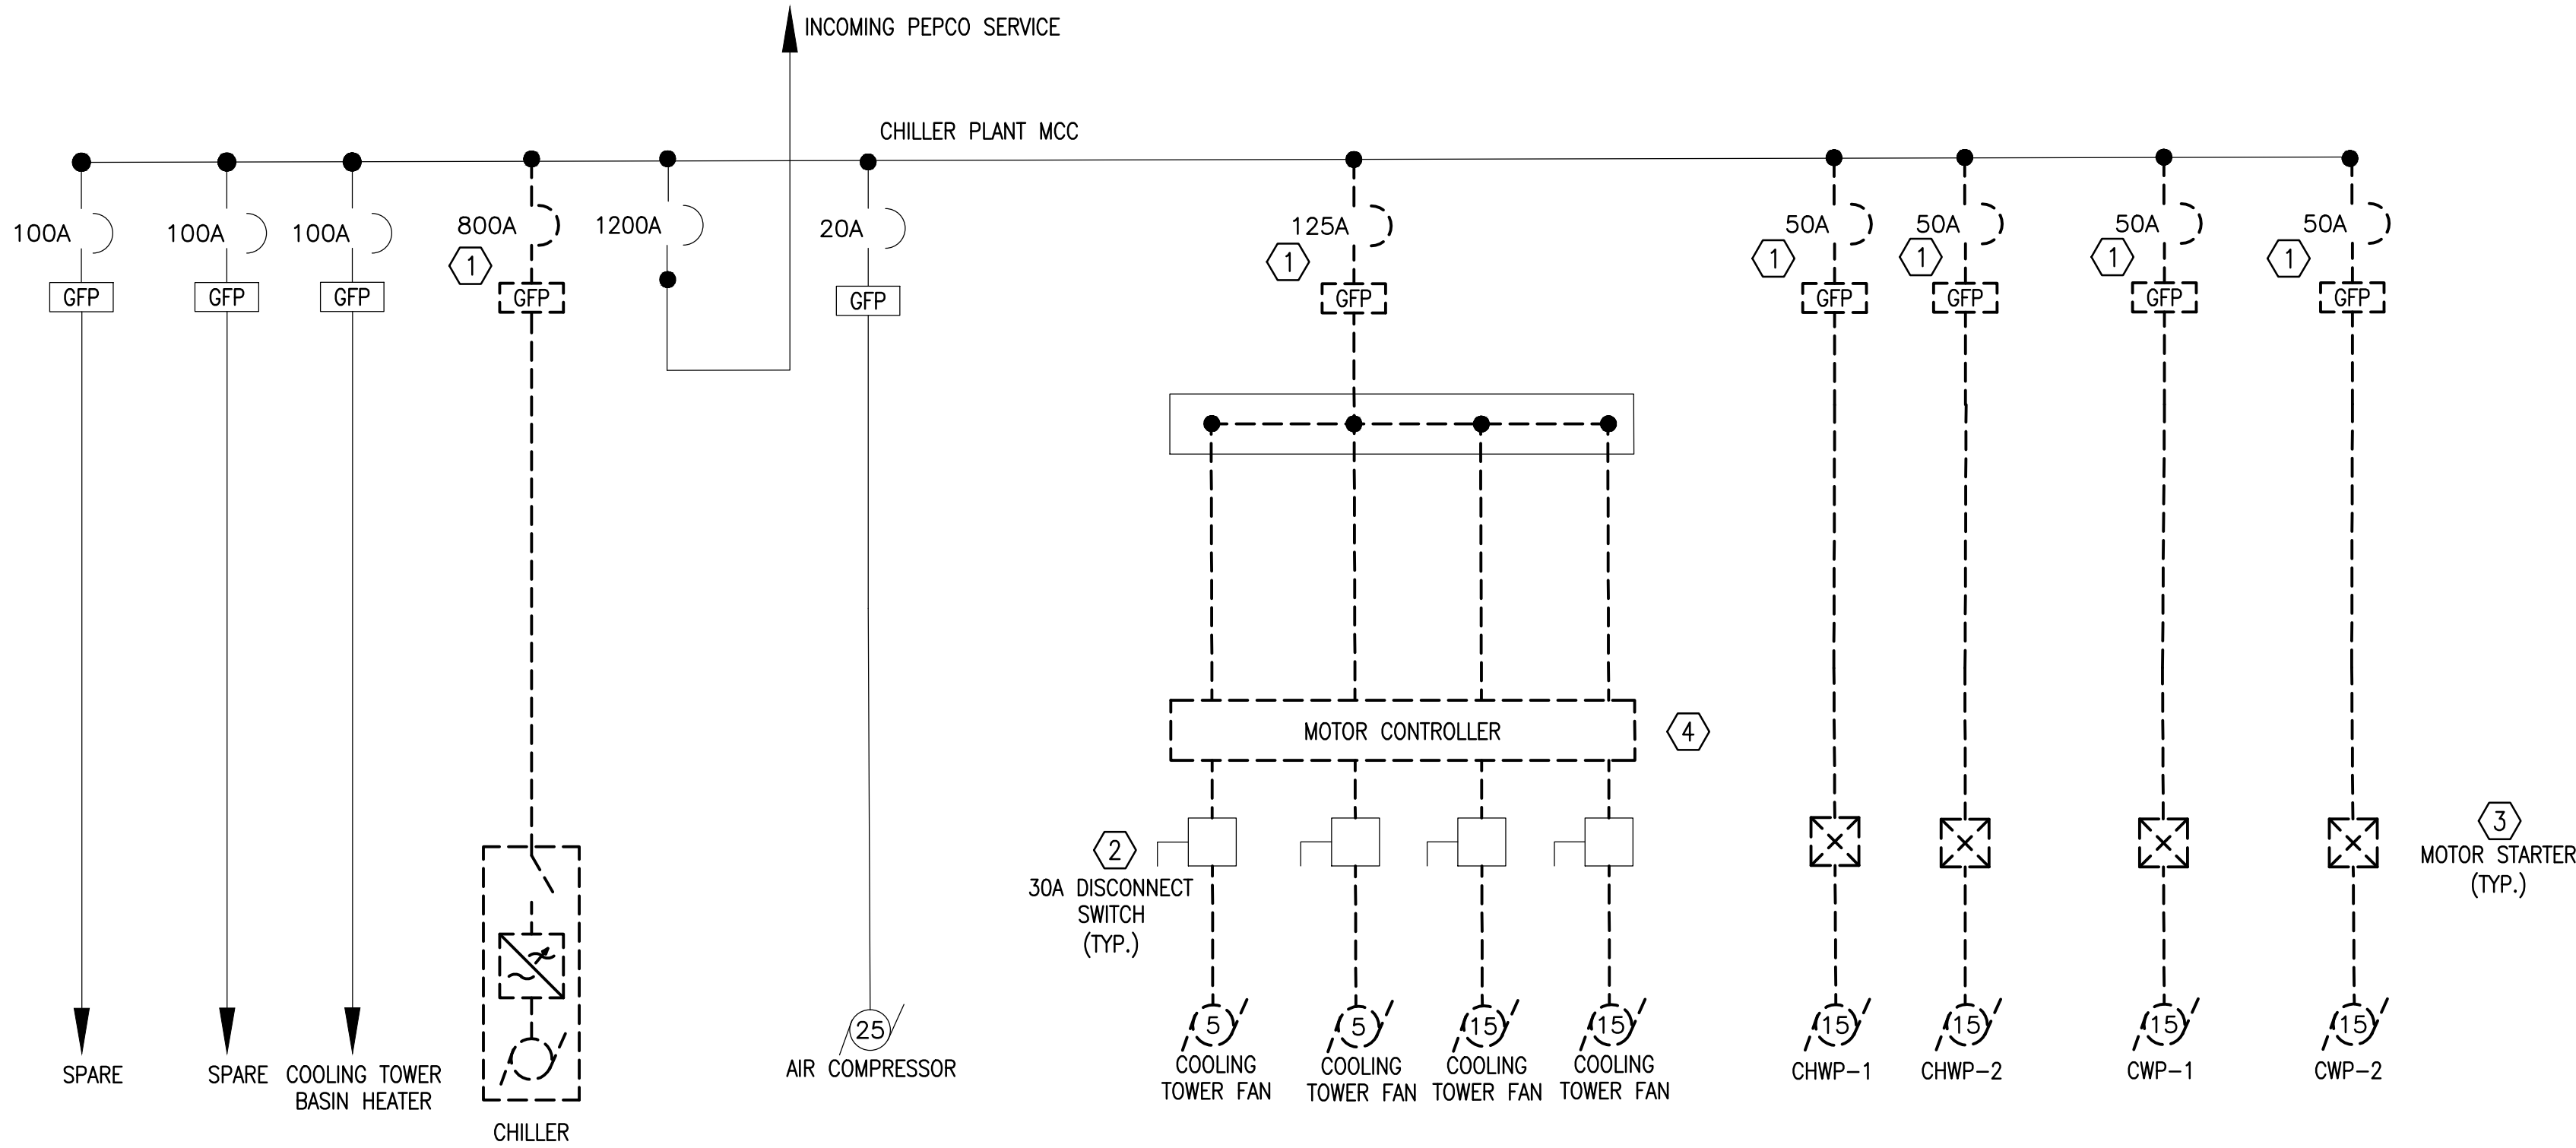

GFP A Gannett Fleming/Parsons
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B ELECTRICAL SINGLE LINE DIAGRAM - DEMOLITION
CWPE3-E-601
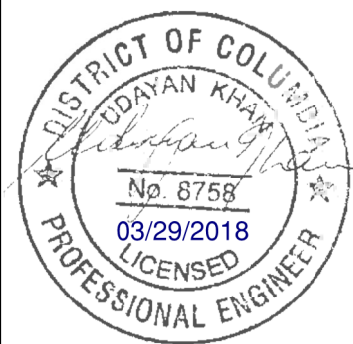
<div>DESIGNED <u>B. IDILBI</u> 09/30/17 DATE</div> <div>DRAWN <u>J. ZHU</u> 09/30/17 DATE</div> <div>CHECKED <u>D. KHAN</u> 03/23/18 DATE</div>	REFERENCE DRAWINGS		REVISIONS			<div><div><div><div>WASHINGTON METROPOLITAN AREA TRANSIT AUTHORITY</div><div>DEPARTMENT OF DESIGN AND CONSTRUCTION SERVICES</div><div>OFFICE OF INFRASTRUCTURE RENEWAL PROGRAM GROUP</div></div><div><div>APPROVED <i>Mark H. Magnusson</i> 03/2018 MARK MAGNUSSEN MANAGER, ENV. PLANNING AND COMP</div><div>DATE</div><div>APPROVED <i>Graham Spiller</i> 03/2018 GRAHAM SPILLER GFP DEPUTY PROGRAM MANAGER</div><div>DATE</div></div></div></div>	REPLACEMENT OF CHILLERS AND COOLING TOWER ACCESSORIES AT EIGHT METRO-RAIL STATIONS CWPE3 - COLUMBIA HEIGHTS (E04) ELECTRICAL SINGLE LINE DIAGRAM - DEMOLITION				
	NUMBER	TITLE	DATE	NUM	DESCRIPTION						
			03/30/2018	0	FINAL CONTRACT DRAWINGS						
M NO.		CONTRACT NO.		SCALE		DRAWING NO.		SHEET NO.			
M1304		FQ-18102		AS NOTED		CWPE3-E-601		109 of 173			

NOTE 3

1A	2A	3A	4A
		3B	4B
1B	2B	3C	4C
	2C	3D	4D
1C	2D	3E	4E
	2E	3F	

SHEET NOTE:

1. PANEL NANSS IS LOCATED IN ROOM C113 WHICH IS ADJACENT TO THE CHILLER PLANT(ROOM C119)
2. THE COOLING TOWER FAN MOTORS SHALL BE CONTROLLED BY HP-RATED VFD AND LINE & LOAD REACTORS.
3. PROVIDE NEW 20A CIRCUIT BREAKERS TO MATCH EXISTING AND WIRE TO NEW LOAD.
4. SEE PLAN NOTE 3 ON DWG CWPE3-E-602.


NOTE 2

NOTE 4

SCALE: NONE

1

[illegible]

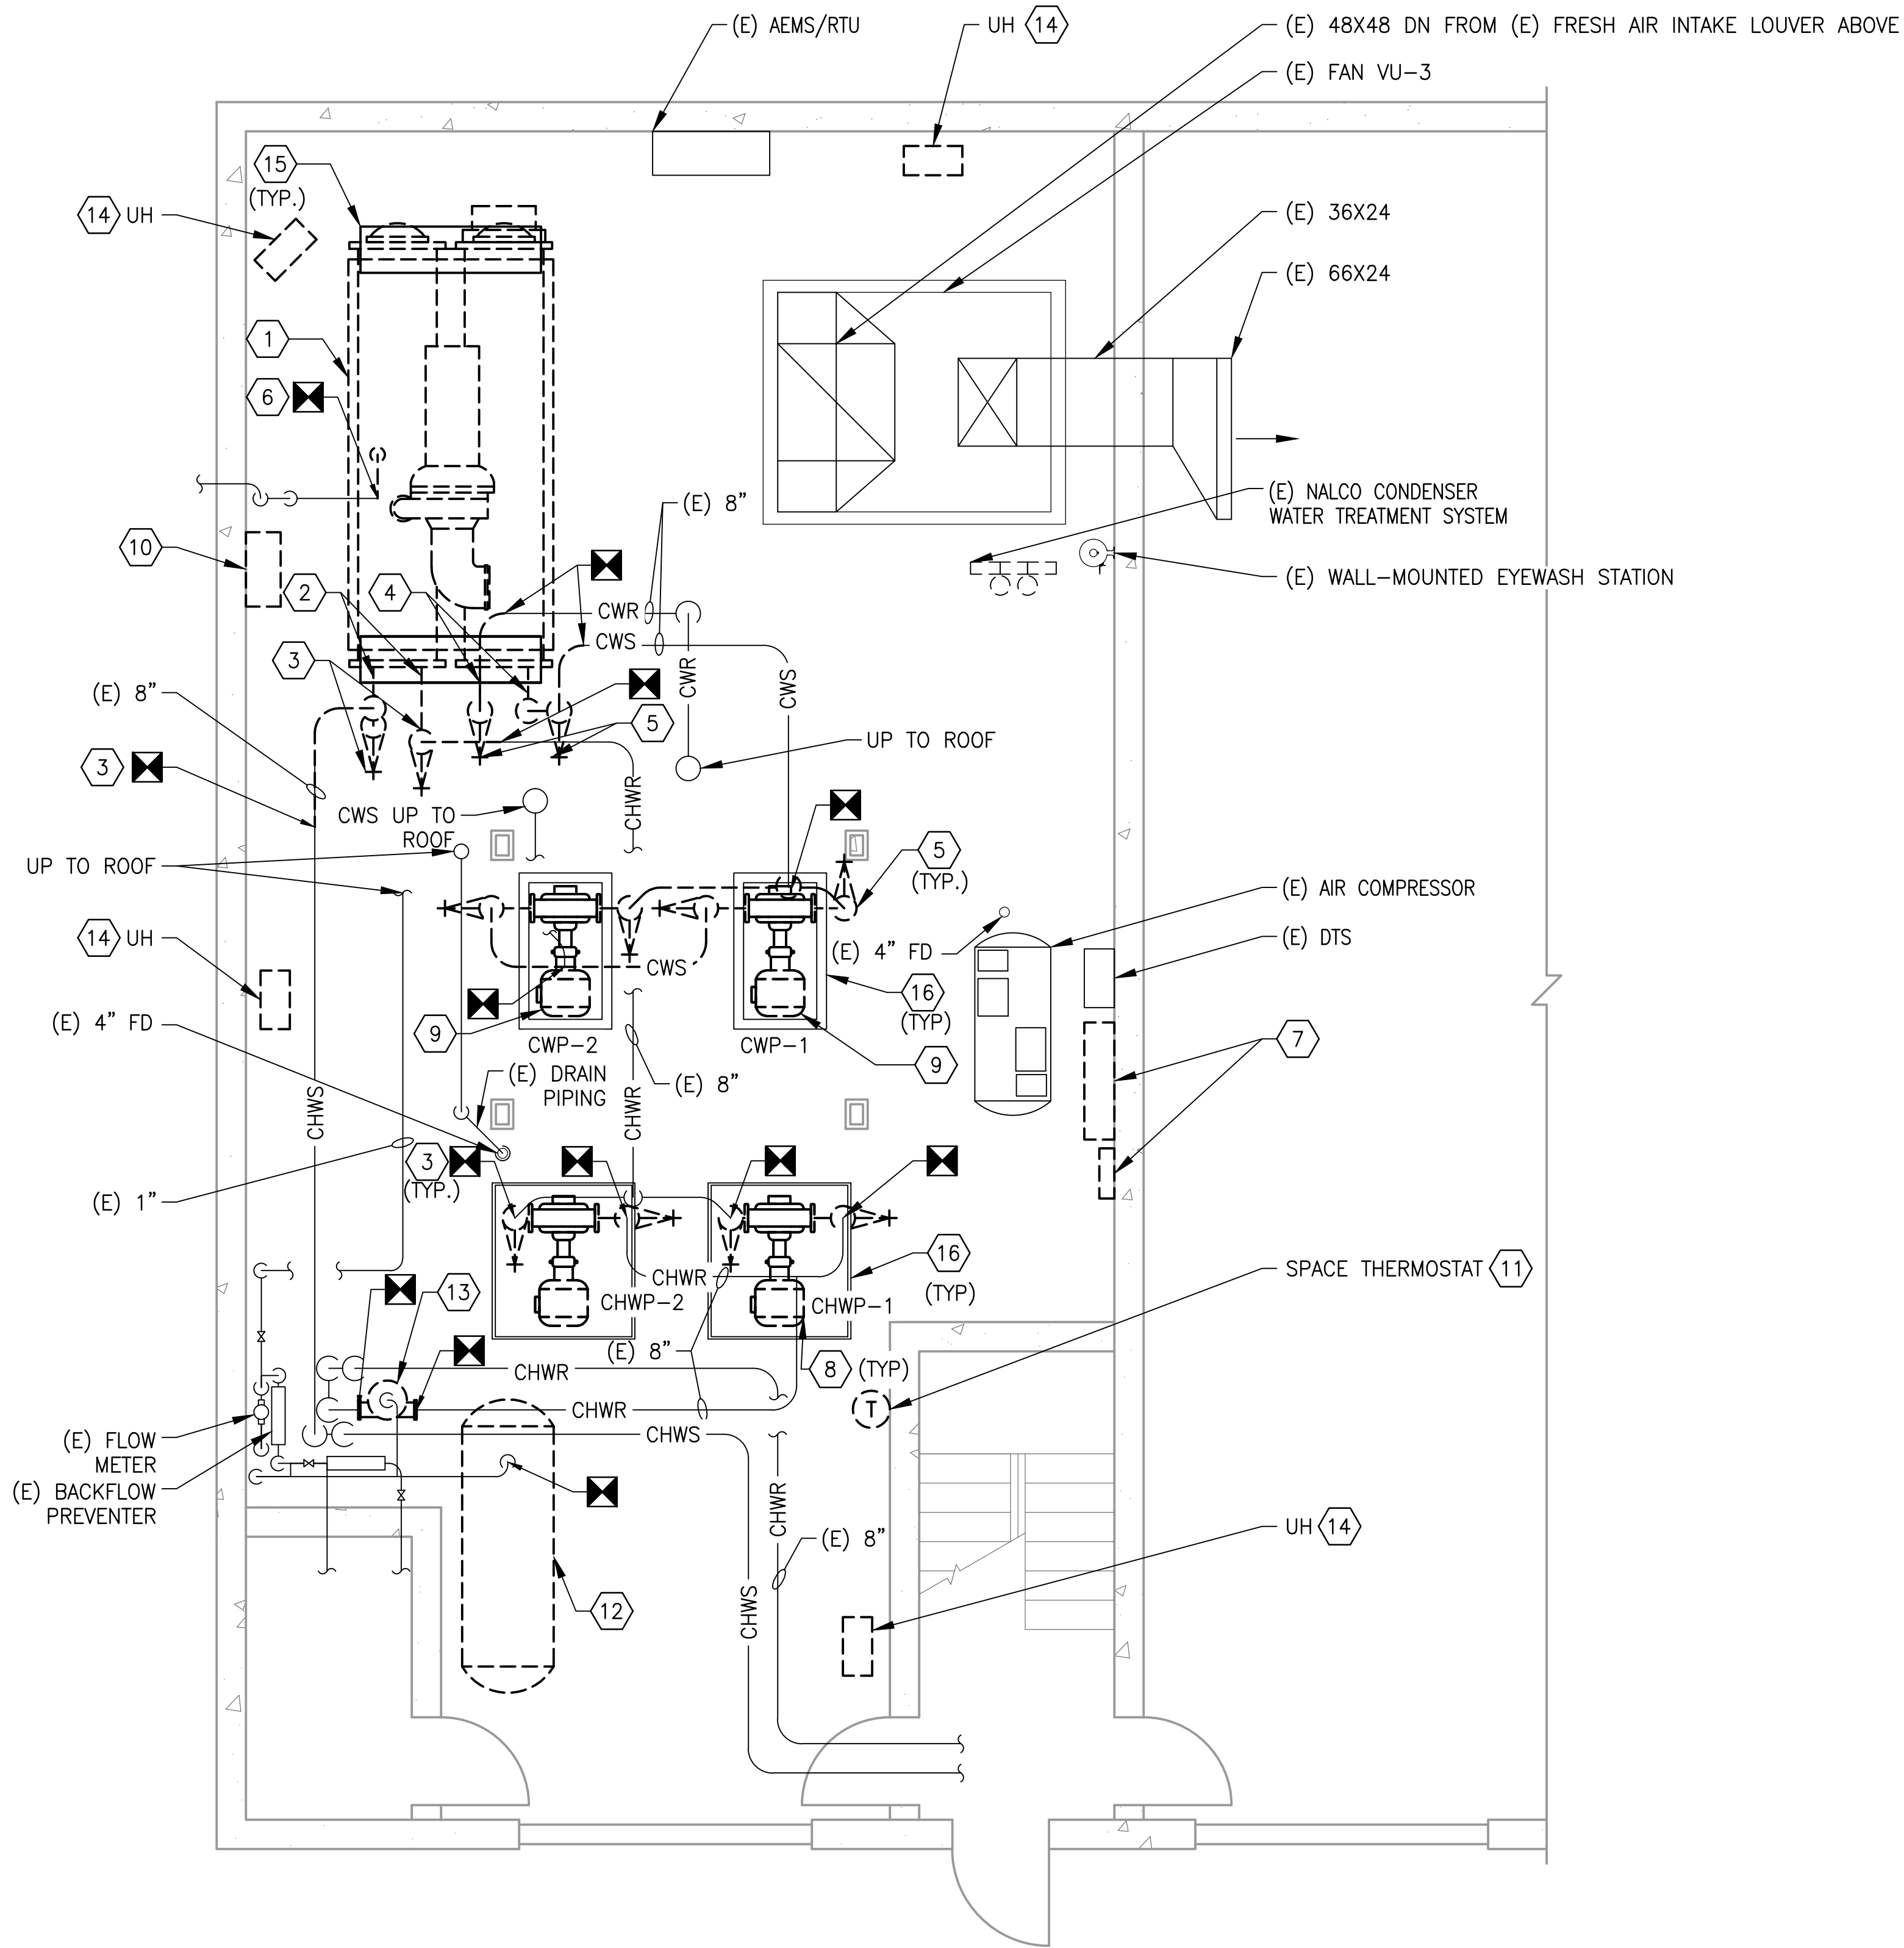

GENERAL NOTES:



- A. CONTRACTOR SHALL FIELD VERIFY EXACT LOCATION AND QUANTITIES OF EQUIPMENT, PIPING, VALVES, DUCTWORK, ELECTRICAL AND CONTROL WIRING PRIOR TO DEMOLITION. ITEMS SHOWN ON THIS PLAN ARE APPROXIMATE.
- B. REFER TO LEGEND SHEET FOR GENERAL ABBREVIATIONS AND SYMBOLS.

KEYNOTES:

- 1 REMOVE AND DISPOSE OF CHILLER, CHILLER SUPPORT, STARTER, WIRING, CONDUIT, JUNCTION/PULL BOXES, DISCONNECT, AEMS SENSORS, AND CONTROLS. REMOVAL SHALL INCLUDE R-134a EVACUATION BY A CERTIFIED COMPANY. RECOVERED REFRIGERANT SHALL BE CLEANED AND THEN RETURNED TO WMATA IN 125 POUND BULLET CONTAINERS.
- 2 REMOVE AND DISPOSE OF CHILLED WATER PIPING (CHWS, CHWR), INSULATION, SUPPORT, TEMPERATURE AND PRESSURE GAUGES. EXTENT OF PIPING REMOVAL SHALL BE, IN GENERAL, TO THE INDICATED ISOLATION VALVE FLANGE FROM THE CHILLER. EXACT DEMOLITION POINT SHALL BE FIELD COORDINATED BY CONTRACTOR TO ACCOMMODATE NEW PIPING CONNECTIONS.
- 3 REMOVE AND DISPOSE OF CHILLED WATER PIPING VALVES AS IDENTIFIED TO BE DEMOLISHED. EXACT QUANTITY OF VALVES SHALL BE VERIFIED BY INSTALLING CONTRACTOR. THE EXTENT OF ALL VALVE REPLACEMENTS SHALL BE INCLUSIVE OF THE CONNECTION FLANGES (TYP.).
- 4 REMOVE AND DISPOSE OF CONDENSER WATER PIPING (CWR, CWS), SUPPORTS, TEMPERATURE AND PRESSURE GAUGES. EXTENT OF PIPING REMOVAL SHALL BE, IN GENERAL, TO THE INDICATED ISOLATION VALVE FLANGE FROM THE CHILLER. EXACT DEMOLITION POINT SHALL BE FIELD COORDINATED BY CONTRACTOR TO ACCOMMODATE NEW PIPING CONNECTIONS.
- 5 REMOVE AND DISPOSE OF THE CONDENSER WATER PIPING VALVE. EXACT QUANTITY OF VALVES SHALL BE FIELD VERIFIED BY INSTALLING CONTRACTOR. THE EXTENT OF ALL VALVE REPLACEMENTS SHALL BE INCLUSIVE OF THE CONNECTION FLANGES (TYP.).
- 6 REMOVE EXISTING 2" REFRIGERANT RELIEF (VENT) PIPING TO EXTENT SHOWN.
- 7 REMOVE AND DISPOSE OF EXISTING JOHNSON CONTROLS CHILLER AND COOLING TOWER CONTROL PANEL.
- 8 REMOVE AND DISPOSE OF CHILLED WATER PUMPS, CHWP-1 AND CHWP-2. REMOVAL SHALL INCLUDE PUMP, MOTOR, POWER AND CONTROL WIRING, CONDUIT, JUNCTION/PULL BOXES, PIPING, SUPPORT, ISOLATION VALVES, STRAINER AND CHECK VALVE, WITH ALL INSTRUMENTATION AND CONTROLS. EXISTING VIBRATION SUPPORT, INERTIAL PAD AND EQUIPMENT TO REMAIN AND BE RE-USED. EXTENT OF PIPING REMOVAL SHALL BE, IN GENERAL, TO THE INDICATED ISOLATION VALVE FLANGE FROM THE CHILLER. EXACT DEMOLITION POINT SHALL BE FIELD COORDINATED BY CONTRACTOR TO ACCOMMODATE NEW PIPING CONNECTIONS.
- 9 REMOVE AND DISPOSE OF CONDENSER WATER PUMPS, CWP-1 AND CWP-2. REMOVAL SHALL INCLUDE PUMP, MOTOR, POWER AND CONTROL WIRING, CONDUIT, JUNCTION/PULL BOXES, PIPING, SUPPORT, ISOLATION VALVES, STRAINER, CHECK VALVE, WITH ALL INSTRUMENTATION AND CONTROLS. EXISTING VIBRATION SUPPORT, INERTIAL PAD AND EQUIPMENT TO REMAIN AND BE RE-USED. EXTENT OF PIPING REMOVAL SHALL BE, IN GENERAL, TO THE INDICATED ISOLATION VALVE FLANGE FROM THE CHILLER. EXACT DEMOLITION POINT SHALL BE FIELD COORDINATED BY CONTRACTOR TO ACCOMMODATE NEW PIPING CONNECTIONS.
- 10 REMOVE AND DISPOSE OF REFRIGERANT MONITORING SENSORS AND PANEL, INCLUDING ALL TUBING, WIRING, AND DEVICES.
- 11 REMOVE AND DISPOSE OF SPACE THERMOSTAT.
- 12 REMOVE AND DISPOSE OF EXISTING EXPANSION TANK. TANK SUPPORT SHALL REMAIN AND BE REUSED.
- 13 REMOVE AND DISPOSE OF EXISTING AIR SEPARATOR. AIR SEPARATOR SUPPORT SHALL REMAIN AND BE REUSED.
- 14 REMOVE AND DISPOSE OF UNIT HEATERS, INCLUDING SUPPORTS, WIRING, CONDUIT, JUNCTION/PULL BOXES AND ANY ASSOCIATED THERMOSTATS. CONTRACTOR SHALL FIELD VERIFY EXACT LOCATIONS OF THERMOSTATS INTERFACED WITH UNIT HEATERS.
- 15 DEMOLISH EXISTING EQUIPMENT PAD. SALVAGE EXISTING VIBRATION SUPPORT AND INERTIA PAD.
- 16 EXISTING EQUIPMENT TO REMAIN, SEE CWPG2-M-101 FOR NEW WORK EQUIPMENT.

1 MECHANICAL PLAN - DEMLOTION
CWPG2-M-100

1/4" = 1'-0"

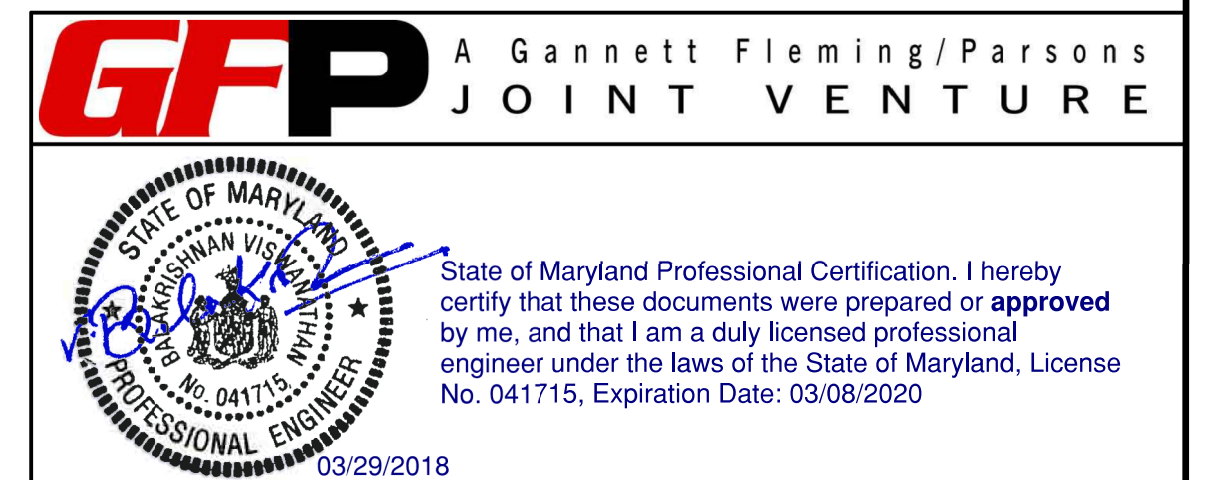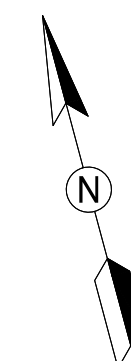

WASHINGTON METROPOLITAN AREA TRANSIT AUTHORITY


DEPARTMENT OF DESIGN AND CONSTRUCTION SERVICES
OFFICE OF INFRASTRUCTURE RENEWAL PROGRAM GROUP

APPROVED *Mark H. Magnusson* 03/2018
MARK MAGNUSSEN
MANAGER, ENV. PLANNING AND COMP

APPROVED *Graham Spiller* 03/2018
GRAHAM SPILLER
GFP DEPUTY PROGRAM MANAGER

REPLACEMENT OF CHILLERS
AND COOLING TOWER ACCESSORIES AT EIGHT METRO-RAIL STATIONS
CWPG2 - CAPITOL HEIGHTS (G02)
MECHANICAL PLAN - DEMOLITION

M NO.	CONTRACT NO.	SCALE	DRAWING NO.	SHEET NO.
M1304	FQ-18102	1/4" = 1'-0"	CWPG2-M-100	112 of 173

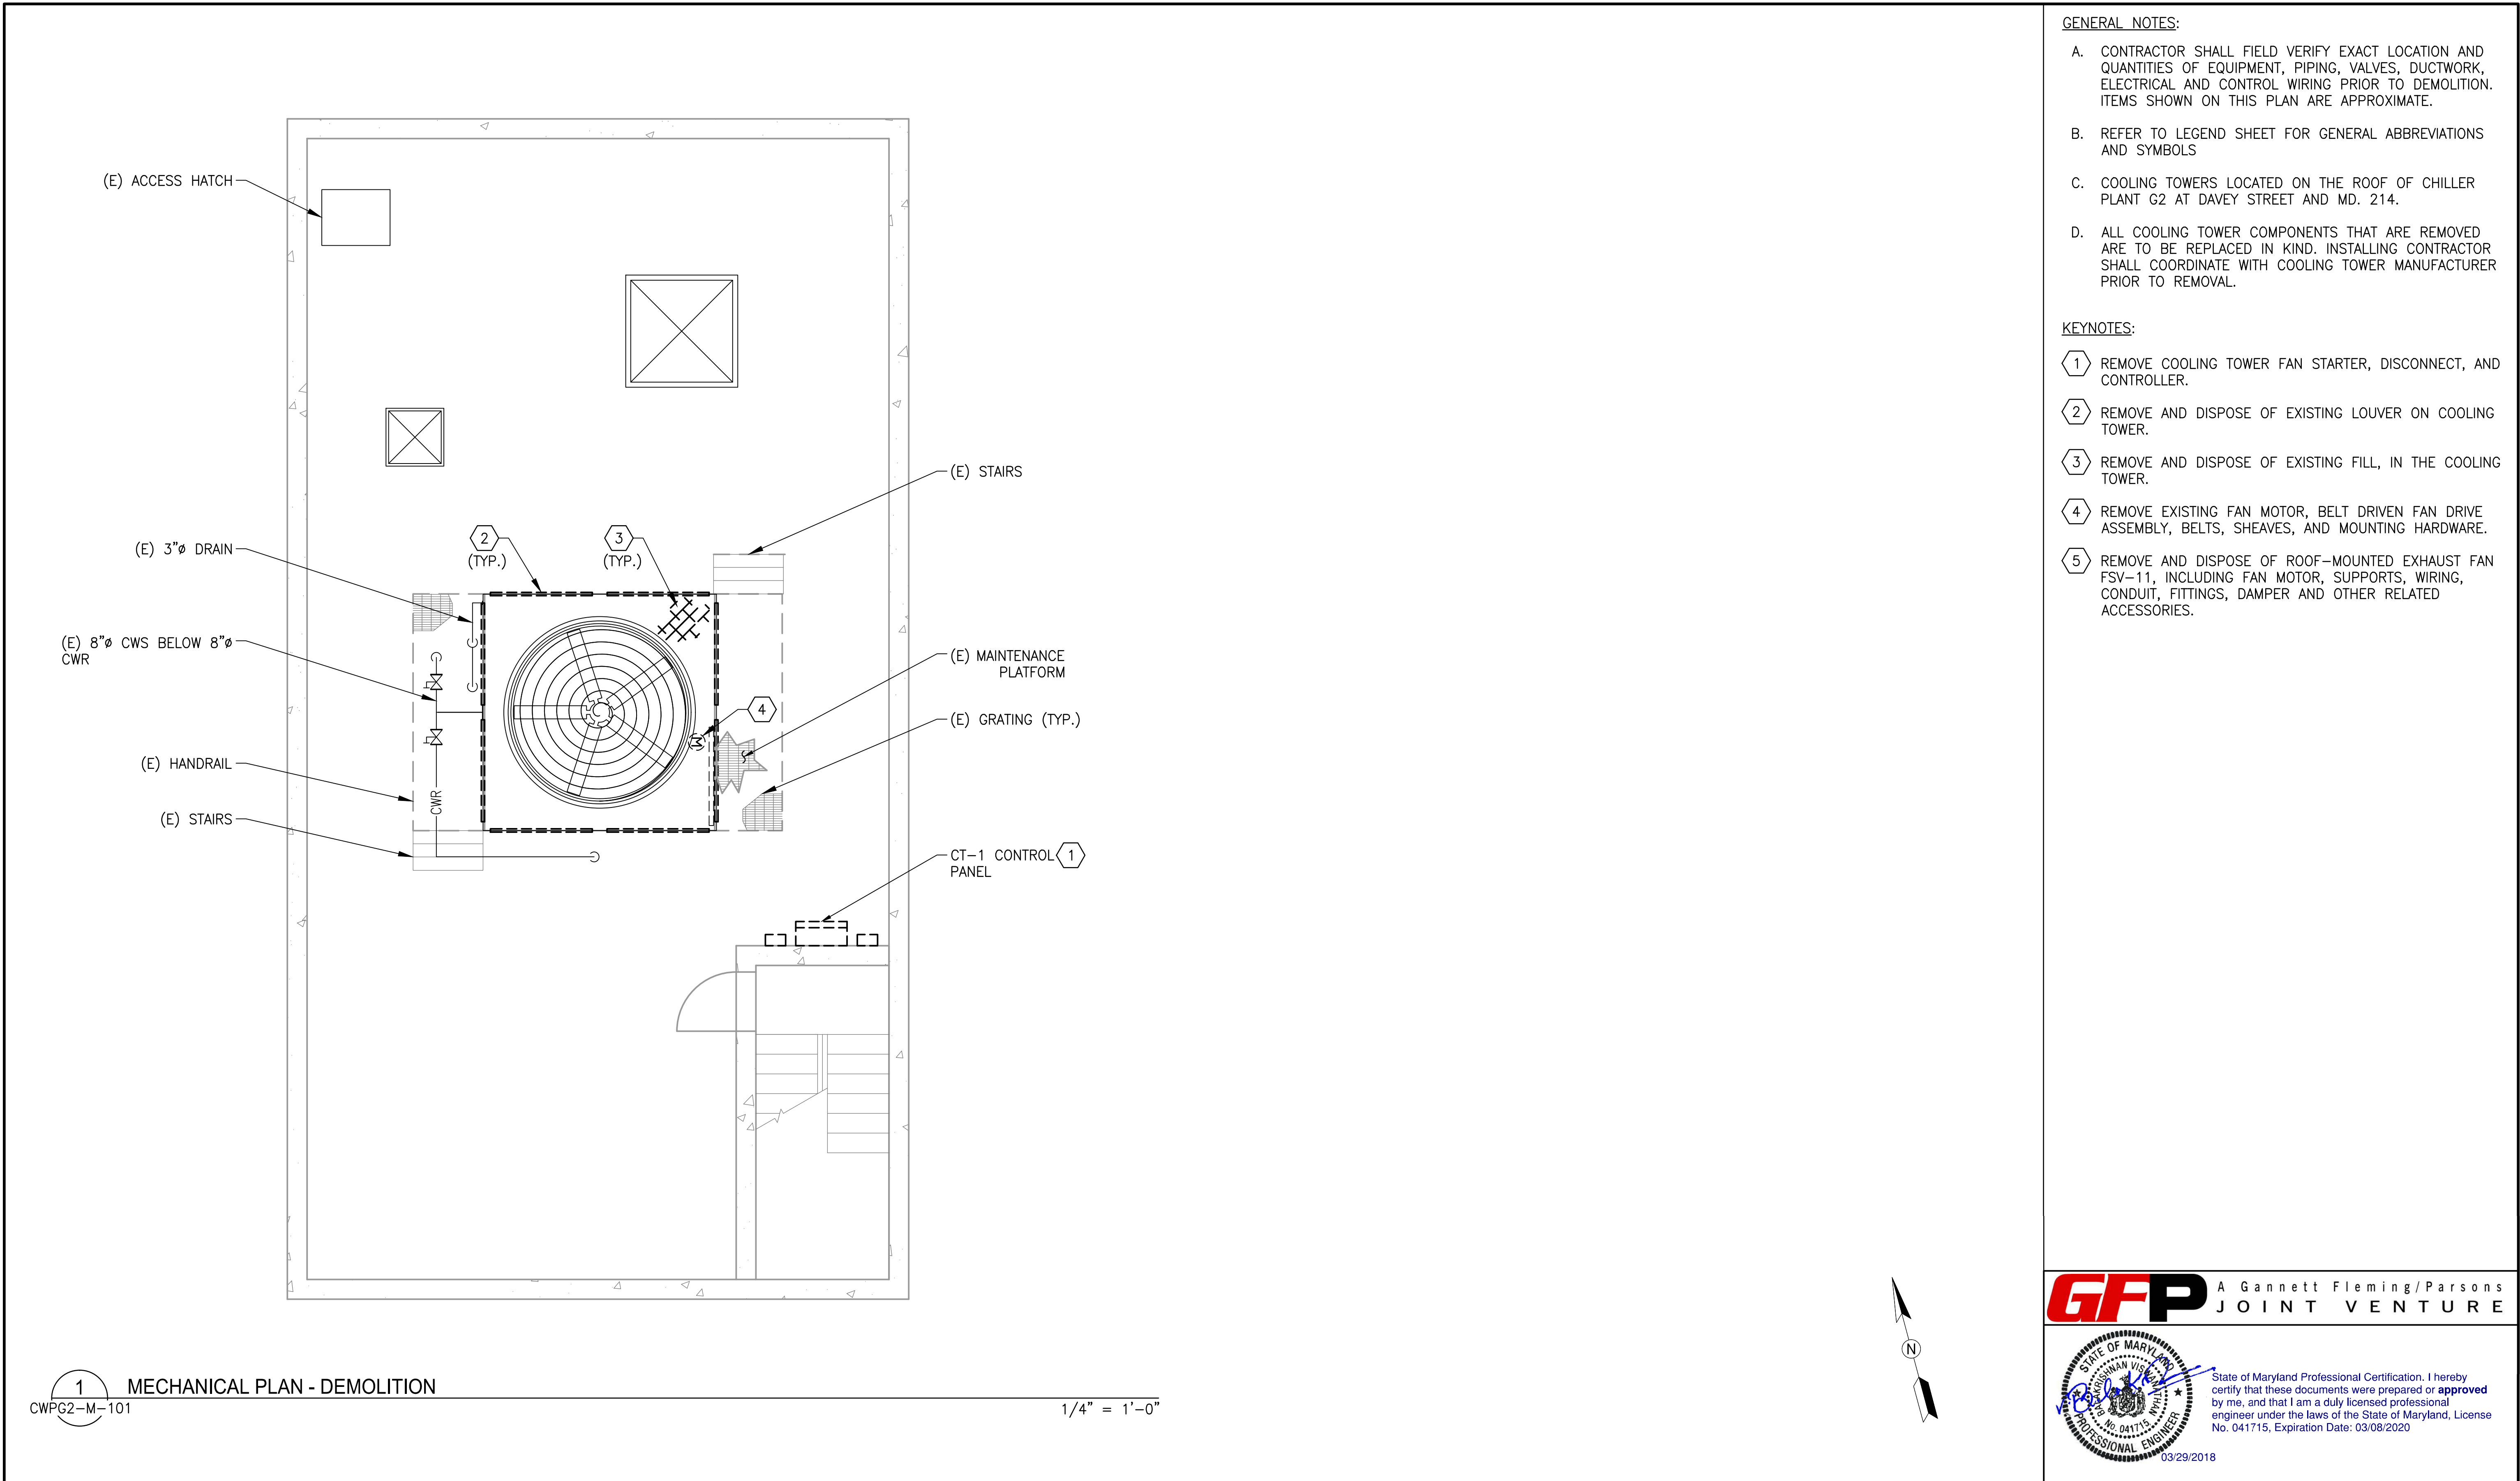


- GENERAL NOTES:
- A. CONTRACTOR SHALL FIELD VERIFY EXACT LOCATION AND QUANTITIES OF EQUIPMENT, PIPING, VALVES, DUCTWORK, ELECTRICAL AND CONTROL WIRING PRIOR TO DEMOLITION. ITEMS SHOWN ON THIS PLAN ARE APPROXIMATE.
 - B. REFER TO LEGEND SHEET FOR GENERAL ABBREVIATIONS AND SYMBOLS
 - C. COOLING TOWERS LOCATED ON THE ROOF OF CHILLER PLANT G2 AT DAVEY STREET AND MD. 214.
 - D. ALL COOLING TOWER COMPONENTS THAT ARE REMOVED ARE TO BE REPLACED IN KIND. INSTALLING CONTRACTOR SHALL COORDINATE WITH COOLING TOWER MANUFACTURER PRIOR TO REMOVAL.

- KEYNOTES:
- 1 REMOVE COOLING TOWER FAN STARTER, DISCONNECT, AND CONTROLLER.
 - 2 REMOVE AND DISPOSE OF EXISTING LOUVER ON COOLING TOWER.
 - 3 REMOVE AND DISPOSE OF EXISTING FILL, IN THE COOLING TOWER.
 - 4 REMOVE EXISTING FAN MOTOR, BELT DRIVEN FAN DRIVE ASSEMBLY, BELTS, SHEAVES, AND MOUNTING HARDWARE.
 - 5 REMOVE AND DISPOSE OF ROOF-MOUNTED EXHAUST FAN FSV-11, INCLUDING FAN MOTOR, SUPPORTS, WIRING, CONDUIT, FITTINGS, DAMPER AND OTHER RELATED ACCESSORIES.

1 MECHANICAL PLAN - DEMOLITION
CWPG2-M-101

1/4" = 1'-0"

<div>DESIGNED <u>B. VISWANATHAN</u> 08/18/17 DATE</div> <div>DRAWN <u>K. STOCKINGER</u> 08/18/17 DATE</div> <div>CHECKED <u>R. SILVA</u> 03/23/18 DATE</div>	REFERENCE DRAWINGS		REVISIONS			<div><div><div><div>M</div><div>metro</div></div><div>WASHINGTON METROPOLITAN AREA TRANSIT AUTHORITY</div><div>DEPARTMENT OF DESIGN AND CONSTRUCTION SERVICES</div><div>OFFICE OF INFRASTRUCTURE RENEWAL PROGRAM GROUP</div></div><div><div>APPROVED <i>Mark H. Magnusson</i> 03/2018</div><div>MARK MAGNUSSEN MANAGER, ENV. PLANNING AND COMP DATE</div></div><div><div>APPROVED <i>Graham Spiller</i> 03/2018</div><div>GRAHAM SPILLER GFP DEPUTY PROGRAM MANAGER DATE</div></div></div>	REPLACEMENT OF CHILLERS AND COOLING TOWER ACCESSORIES AT EIGHT METRO-RAIL STATIONS CWPG2 - CAPITOL HEIGHTS (G02) MECHANICAL PLAN - DEMOLITION				
	NUMBER	TITLE	DATE	NUM	DESCRIPTION		M NO.	CONTRACT NO.	SCALE	DRAWING NO.	SHEET NO.
			03/30/2018	0	FINAL CONTRACT DRAWINGS		M1304	FQ-18102	1/4" = 1'-0"	CWPG2-M-101	113 of 173

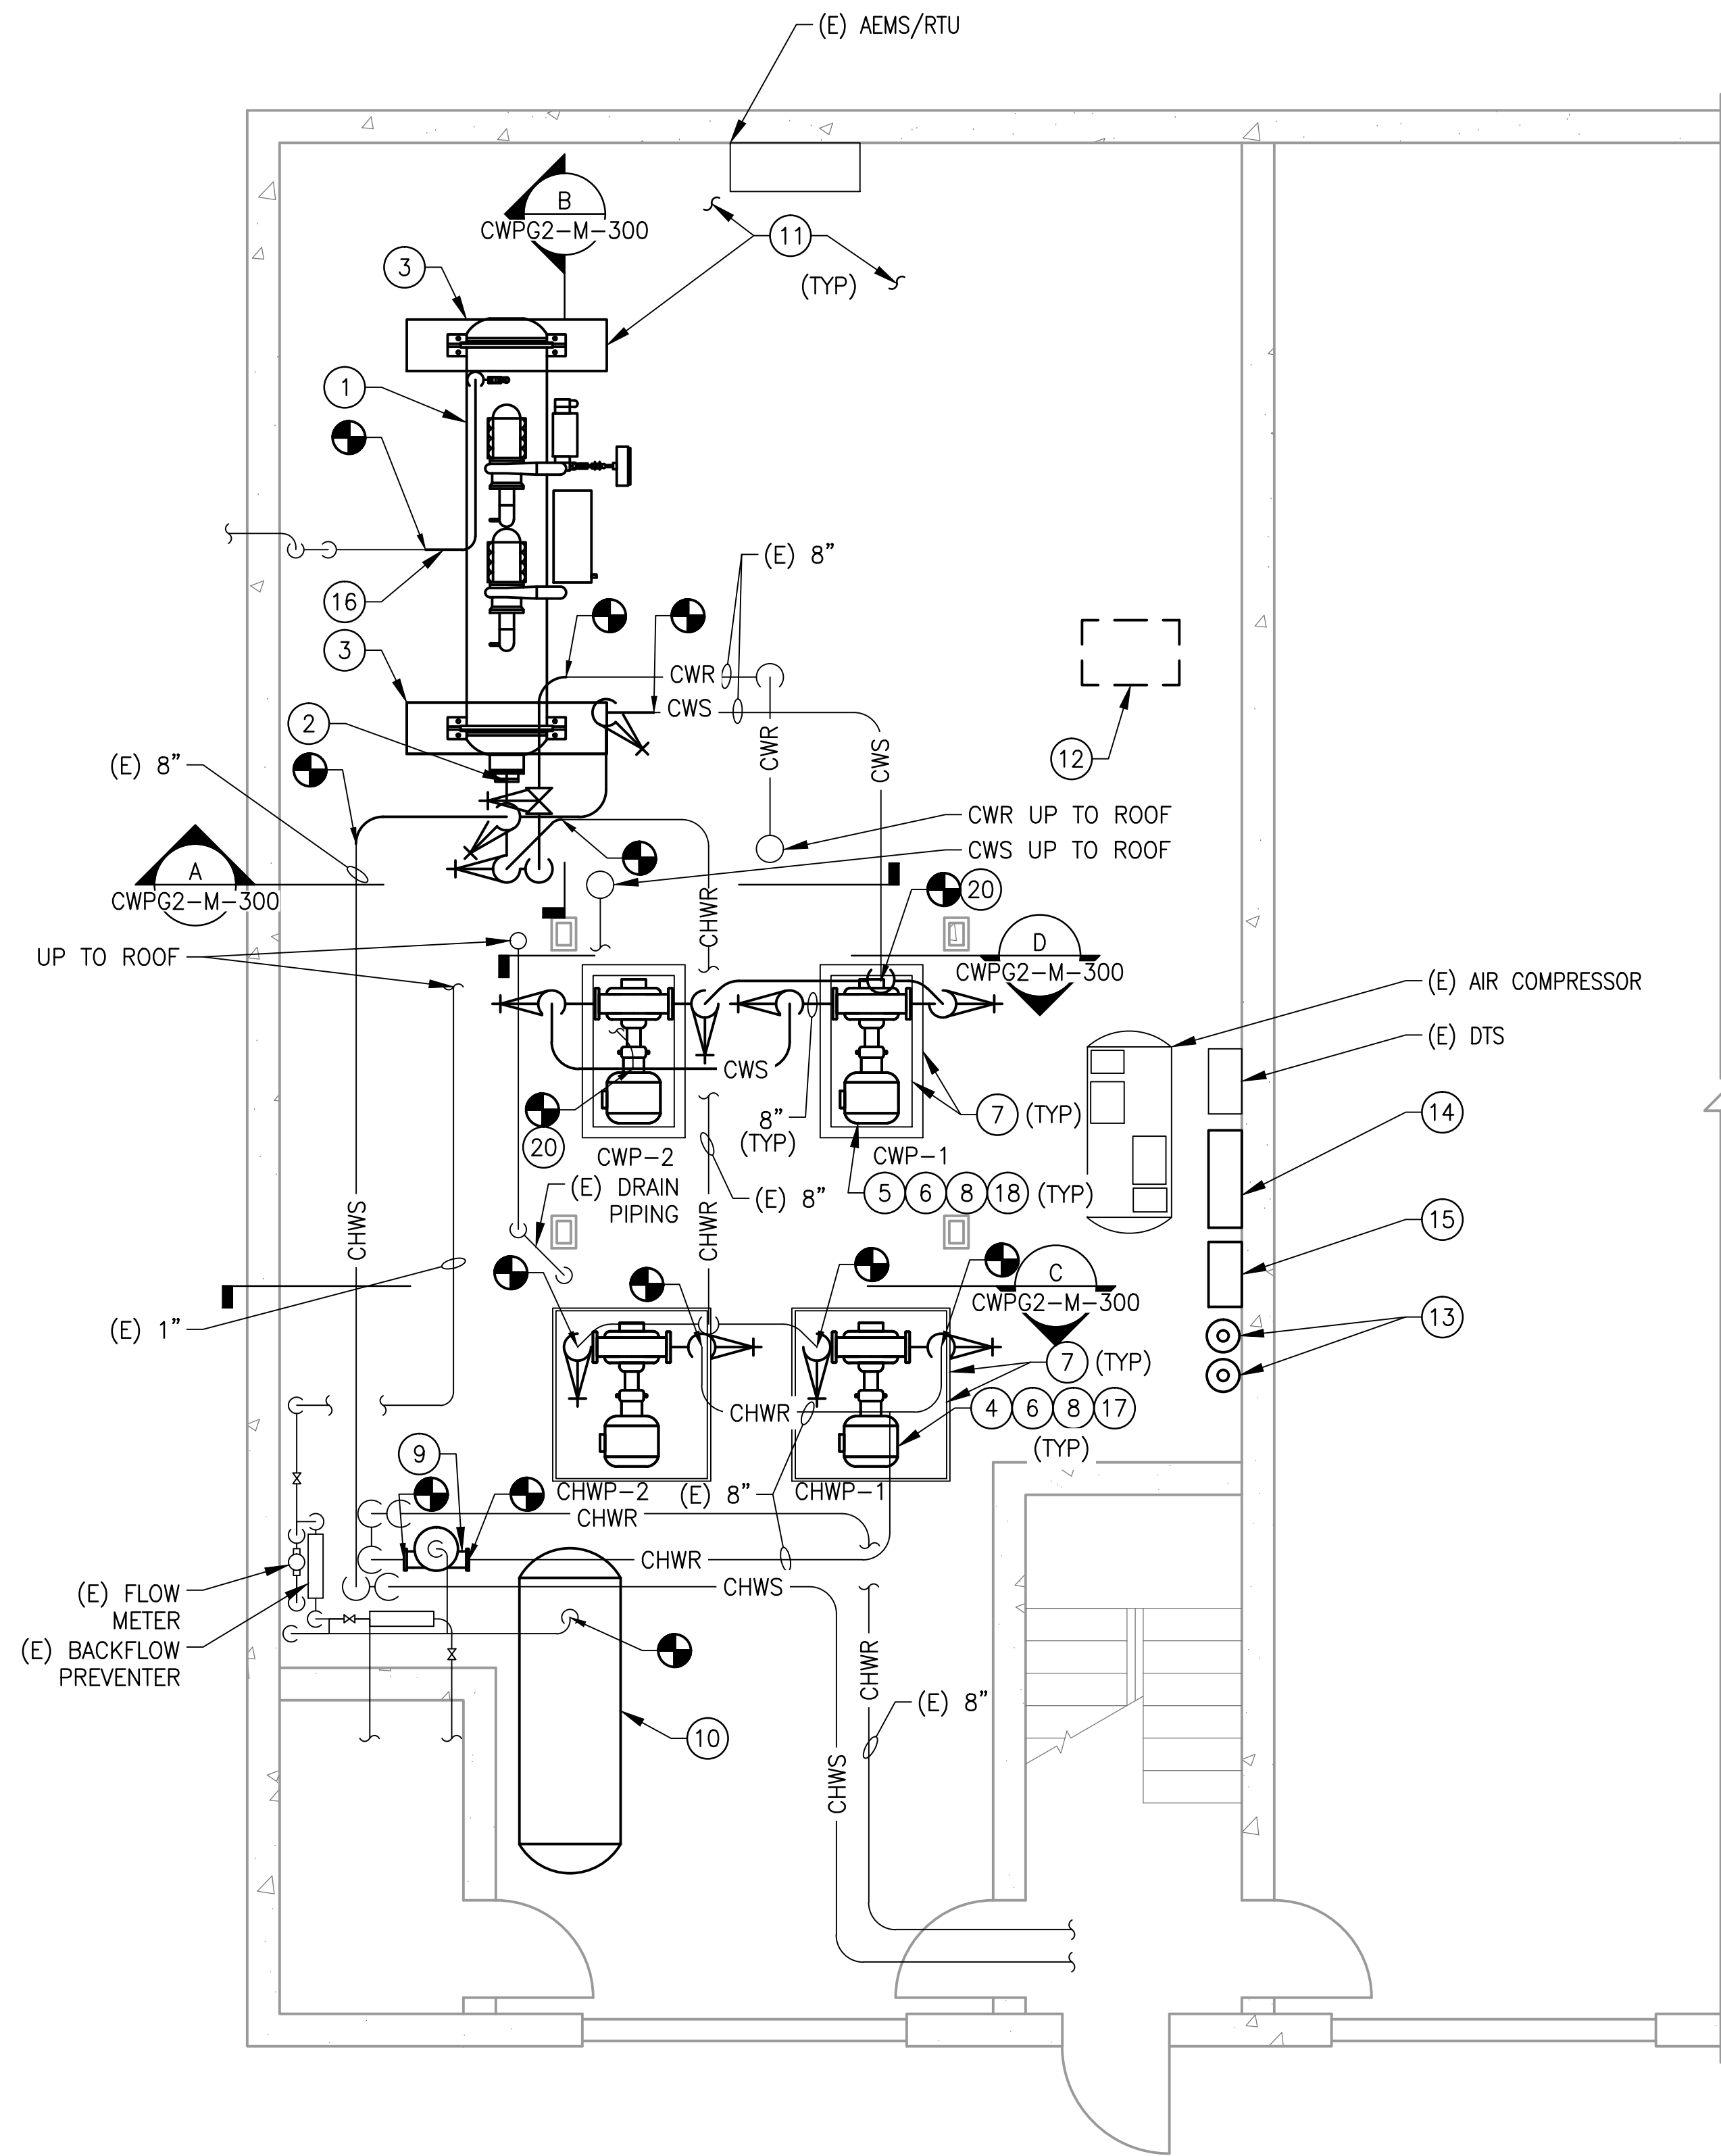

GENERAL NOTES:

- A. CONTRACTOR SHALL FIELD VERIFY AND COORDINATE LOCATION OF NEW EQUIPMENT, PIPING, VALVES, DUCTWORK, ELECTRICAL AND CONTROL WIRING WITH EXISTING PRIOR TO INSTALLATION. ITEMS SHOWN ON THIS PLAN ARE APPROXIMATE.

B. REFER TO LEGEND SHEET FOR GENERAL ABBREVIATIONS AND SYMBOLS.
- C. REFER TO CHILLER PIPING SCHEMATIC FOR ALL VALVES. ALL VALVES MAY NOT BE SHOWN ON THIS DRAWING FOR CLARITY.

D. INSTALL ALL EQUIPMENT AND COMPONENTS PER MANUFACTURERS RECOMMENDATION. PROVIDE ACCESS CLEARANCE AT ALL LOCATION OF VALVES, STRAINER, INSTRUMENTATION AND EQUIPMENT AS REQUIRED BY MANUFACTURER AND FOR EASE OF MAINTENANCE.

KEYNOTES:

- 1 PROVIDE AND INSTALL CHILLER, CORRESPONDING VIBRATION ISOLATION, ANCHOR AND SUPPORT.

2 PROVIDE AND INSTALL ALL PIPING, FITTINGS, VALVES, PIPING INSULATION AND INSTRUMENTATION FOR CONNECTION TO CHILLER. PROVIDE A VICTAULIC COUPLING CONNECTION PIECE AT EACH PIPE CONNECTION TO CHILLER FOR EASE OF MAINTENANCE.

3 PROVIDE NEW EQUIPMENT PAD. VERIFY LOCATION IN FIELD.

4 PROVIDE AND INSTALL CHILLED WATER PUMPS, CHWP-1 AND CHWP-2. INSTALLATION SHALL INCLUDE PUMP, INVERTER DUTY RATED MOTOR FOR VFD APPLICATION, VIBRATION SUPPORT, IMMEDIATE PIPING, ISOLATION VALVES, CHECK VALVES, STRAINER, FLEXIBLE CONNECTORS AND CORRESPONDING INSTRUMENTATION & CONTROLS. INSULATE PUMPS AND PIPING.

5 PROVIDE AND INSTALL CONDENSER WATER PUMPS, CWP-1 AND CWP-2. INSTALLATION SHALL INCLUDE PUMP, INVERTER DUTY RATED MOTOR FOR VFD APPLICATION, VIBRATION SUPPORT, IMMEDIATE PIPING, ISOLATION VALVES, CHECK VALVES, STRAINER, FLEXIBLE CONNECTORS AND CORRESPONDING INSTRUMENTATION & CONTROLS.

6 INTEGRATE PUMP VFD DRIVES WITH CHILLER CONTROL PANEL. REFER TO ELECTRICAL DRAWINGS FOR EXACT LOCATION OF VFD's.

7 REUSE EXISTING EQUIPMENT PAD, SPRING ISOLATOR AND INERTIA PAD. REPAIR AND MODIFY AS REQUIRED TO FIT NEW INSTALLATION.

8 PROVIDE AND INSTALL ALL APPROPRIATE PIPE FITTINGS FOR CONNECTION TO PUMPS.

9 PROVIDE AND INSTALL AIR SEPARATOR, CORRESPONDING PIPING AND SUPPORTS. INSULATE AIR SEPARATOR AND PIPING.

10 PROVIDE AND INSTALL EXPANSION TANK AND CORRESPONDING PIPING. REUSE EXISTING CEILING MOUNTED SUPPORT.

11 CONTRACTOR SHALL PAINT CHILLER PLANT FLOORS AND EQUIPMENT PADS WITH BATTLE SHIP GREY OR EQUAL. THE SAFETY LINES AND TRIPPING HAZARD SHALL BE PAINTED YELLOW OR RED.

12 A. COORDINATE WITH OTHER WMATA CONTRACT INSTALLING WATER TREATMENT SYSTEM.
B. PROVIDE AND INSTALL NEW WMATA CHILLED WATER SYSTEM LOOP. THE LOOP SHALL INCLUDE PIPING, VALVES, HACH INDUCTIVE CONDUCTIVITY SENSOR - 3725E2T, FLOW SWITCH GEM SENSORS FS-500 170231, AND CONVERTIBLE DIGITAL PH SENSOR HACH DPC1R2A. REFER TO REFERENCE DRAWING DD-ME-HVAC-007.
C. PROVIDE AND INSTALL A NEW WMATA CONDENSER WATER SYSTEM LOOP. THE LOOP SHALL INCLUDE PIPING, VALVES, HACH INDUCTIVE CONDUCTIVITY SENSOR - 3725E2T, FLOW SWITCH GEM SENSORS FS-500 170231. REFER TO REFERENCE DRAWING DD-ME-HVAC-008.
- 13 PROVIDE AND INSTALL CHEMICAL POT FEEDER FOR CONDENSER WATER AND CHILLED WATER SYSTEM. CHEMICAL POT FEEDER SHALL BE NEPTUNE VTF-5HF.

14 PROVIDE AND INSTALL ONE CHILLER PLANT CONTROL PANEL (CPCP). REFER TO REFERENCE DRAWINGS DD-ME-HVAC-009 FOR CPCP DETAILS. PANEL SHALL BE INSTALLED 48" ABOVE FINISHED FLOOR.

15 PROVIDE AND INSTALL CHILLED WATER AND CONDENSER WATER FLOW MONITORING SYSTEM. PROVIDE AND INSTALL COMMUNICATIONS WIRING IN RIGID CONDUIT FROM FLOW MONITORING PANE TO CHILLER PLANT CONTROL PANEL, UTILIZING BELDEN 89842 MULTI-CONDUCTOR; LOW CAPACITANCE TO COMPUTER POINT OF SERVICE (POS) CABLE OR EQUIVALENT. INSTALL 48" ABOVE FINISHED FLOOR. FLOW METER SHALL BE INSTALLED IN ACCORDANCE WITH MANUFACTURER'S RECOMMENDED INSTALLATION PROCEDURES. FLOW METERS AND SENSOR CABLES SHOULD NOT BE INSTALLED WITHIN EIGHT FEET OF VFDs OR FLORESCENT LIGHT FIXTURES.

16 PROVIDE AND INSTALL REFRIGERANT VENT/ RELIEF PIPING FROM CHILLER (AS PER CHILLER MANUFACTURER). FIELD VERIFY AND CONNECT NEW 2" REFRIGERANT RELIEF PIPING FROM CHILLER TO EXISTING REFRIGERANT RELIEF MAIN.

17 PROVIDE 8" STRAINER AND 8" TO 5" ANGLE FLANGE FOR 8" CHILLED PIPING INLET INTO CHILLED WATER PUMP. PROVIDE A 4" TO 8" ANGLE FLANGE AT CHILLED WATER PUMP OUTLET FOR CONNECTION TO CHILLED WATER DISCHARGE PIPING.


18 PROVIDE 8" STRAINER AND 8" TO 8" ANGLE FLANGE FOR 8" CONDENSER WATER PIPING INLET INTO CONDENSER WATER PUMP. PROVIDE A 6" TO 8" ANGLE FLANGE AT CONDENSER WATER PUMP OUTLET FOR CONNECTION TO CONDENSER WATER DISCHARGE PIPING.

19 PROVIDE FLOOR MOUNTED, PIPE SADDLE SUPPORT WITH BASE STAND AS NECESSARY FOR NEW PIPING. CHILLED WATER PIPING SUPPORTS SHALL BE PRE-INSULATED.

20 PROVIDE NECESSARY FITTINGS TO CONNECT NEW WORK PIPE TO EXISTING PIPE AT POINT SHOWN.

1 MECHANICAL PLAN - NEW WORK
CWPG2-M-102

1/4" = 1'-0"

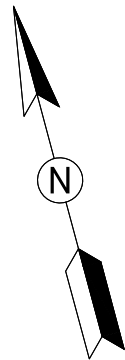

GFP A Gannett Fleming/Parsons
JOINT VENTURE

State of Maryland Professional Certification. I hereby certify that these documents were prepared or approved by me, and that I am a duly licensed professional engineer under the laws of the State of Maryland, License No. 041715, Expiration Date: 03/09/2020



WASHINGTON METROPOLITAN AREA TRANSIT AUTHORITY

DEPARTMENT OF DESIGN AND CONSTRUCTION SERVICES
OFFICE OF INFRASTRUCTURE RENEWAL PROGRAM GROUP

APPROVED *Mark H. Magnusson* 03/2018
MARK MAGNUSSEN
MANAGER, ENV. PLANNING AND COMP

APPROVED *Gabe Spiller* 03/2018
GRAHAM SPILLER
GFP DEPUTY PROGRAM MANAGER

REPLACEMENT OF CHILLERS
AND COOLING TOWER ACCESSORIES AT EIGHT METRO-RAIL STATIONS
CWPG2 - CAPITOL HEIGHTS (G02)
MECHANICAL PLAN - NEW WORK

M NO.	CONTRACT NO.	SCALE	DRAWING NO.	SHEET NO.
M1304	FQ-18102	1/4" = 1'-0"	CWPG2-M-102	114 of 173

